

PROJECT:

D.A.D.A. - ART GALLERY

Council Agenda - 31 October 2019 - Agenda Item 8.2

Attachment 2 - Plans to be endorsed - 90-110 Cimitiere Street Launceston -

ADDRESS:

90-110 WILLIS ST LAUNCESTON TAS 7250

PROJECT No:

18302

STATUS:

FOR PLANNING

ISSUED FOR / DESCRIPTION

DEVELOPMENT APPLICATION

DRAWINGS

A00 - COVER SHEET

A01 - SITE PLAN

A02 - FLOOR PLAN - L1

A03 - FLOOR PLAN - L2

A04 - FLOOR PLAN - L3

A05 - FLOOR PLAN - L4

A06 - FLOOR PLAN - L5

A07 - FLOOR PLAN - L6

A08 - ROOFING PLAN

A09 - DIMENSIONED FLOOR PLAN - L1

A10 - DIMENSIONED FLOOR PLAN - L2

A11 - DIMENSIONED FLOOR PLAN - L3

A12 - DIMENSIONED FLOOR PLAN - L4

A13 - DIMENSIONED FLOOR PLAN - L5

A14 - DIMENSIONED FLOOR PLAN - L6

A15 - DIMENSIONED ROOFING PLAN

A16 - SECTION - SHEET 1

A17 - SECTION - SHEET 2

A18 - ELEVATION - SHEET 1

A19 - ELEVATION - SHEET 2

A20 - ELEVATION - SHEET 3

A21 - ELEVATION - SHEET 4

A22 - 3D VIEW - SHEET 1

A23 - 3D VIEW - SHEET 2


A24 - 3D VIEW - SHEET 3

A25 - 3D VIEW - SHEET 4

A26 - SHADOW DIAGRAMS - EXISTING

A27 - SHADOW DIAGRAMS - PROPOSED

DADA art gallery

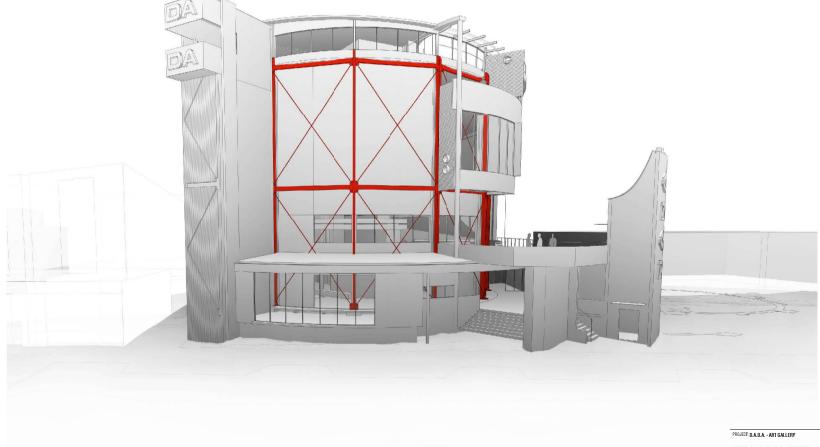

ADDRESS: 90-110 WILLIS ST LAUNCESTON TAS 7250

TITLE COVER SHEET

RH 19-07-29

BY: DATE:

C AMENDED TO ANSWER REI'S

REV: DESCRIPTION:

B AMENDMENT TO DEVELOPMENT APPLICATION

FOR PLANNING DESIGN BY: R.H,J.C DRAWN BY: J.C

DESIGN CHK: R.H. DRAFT CHK: RH

SCALE: SHEET SIZE: A1 DWGs IN SET: PROJECT No: 18302 DWG No: A00 REV: B APPROVED: BH. ACRED No. 009830. DATE 10.06.18













TRUE NORTH

TYPE

BUILDING FOOTPRINT 771.4m2 186.9m2 SHARED RIGHT OF WAY TOTAL SITE AREA
PROPOSED SITE
PROPOSED SITE BUILDING
COVERAGE 1109.8m2

FLDDR AREAS				
RL1	657.4m2			
RL2	568.7m2			
RL3	508.8m2			
RL4	380.6m2			
RL5	522.6m2			
RL6	543.1m2			
TOTAL	3181.2m2			

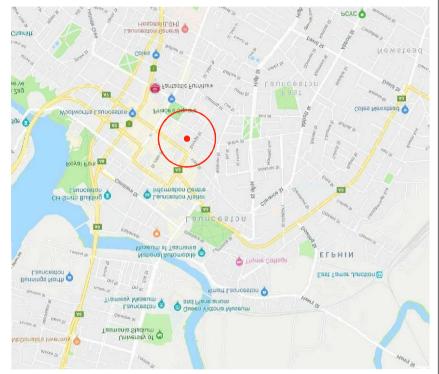

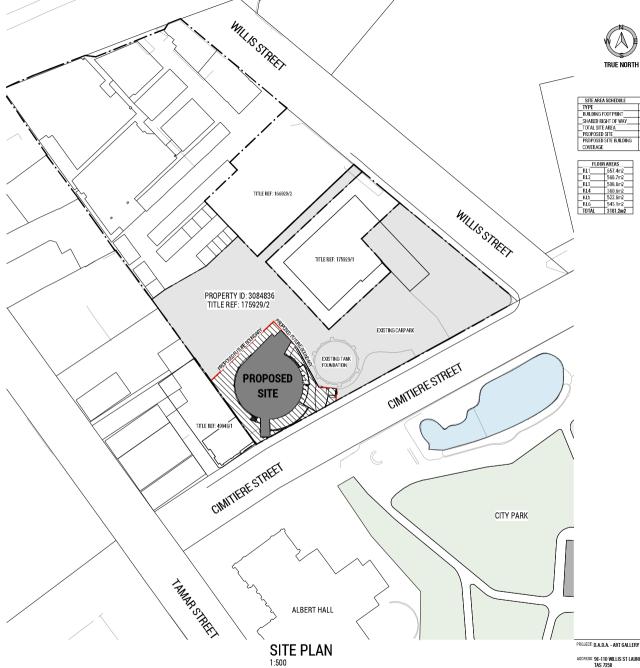

LOCATION PLAN

REV: DESCRIPTION:

DESIGN BY: R.H,J.C DRAWN BY: J.C .0408340743 e. nchard@rarch.com.au

C AMENDED TO ANSWER RFI's B AMENDMENT TO DEVELOPMENT APPLICATION
A DEVELOPMENT APPLICATION RH 19-07-29 RH 19-06-18


BY: DATE:

ADDRESS: 90-110 WILLIS ST LAUNCESTON TAS 7250

TITLE SITEPLAN STATUS: FOR PLANNING

DESIGN CHK: R.H DPAFT CHK: RH

SCALE: As indicated EET SIZE: A1 DWGs IN SET: PROJECT No: 18302 DWG No: A01 REV: B APPROVED: RH ACRED. No: 002830 DATE: 19-06-18

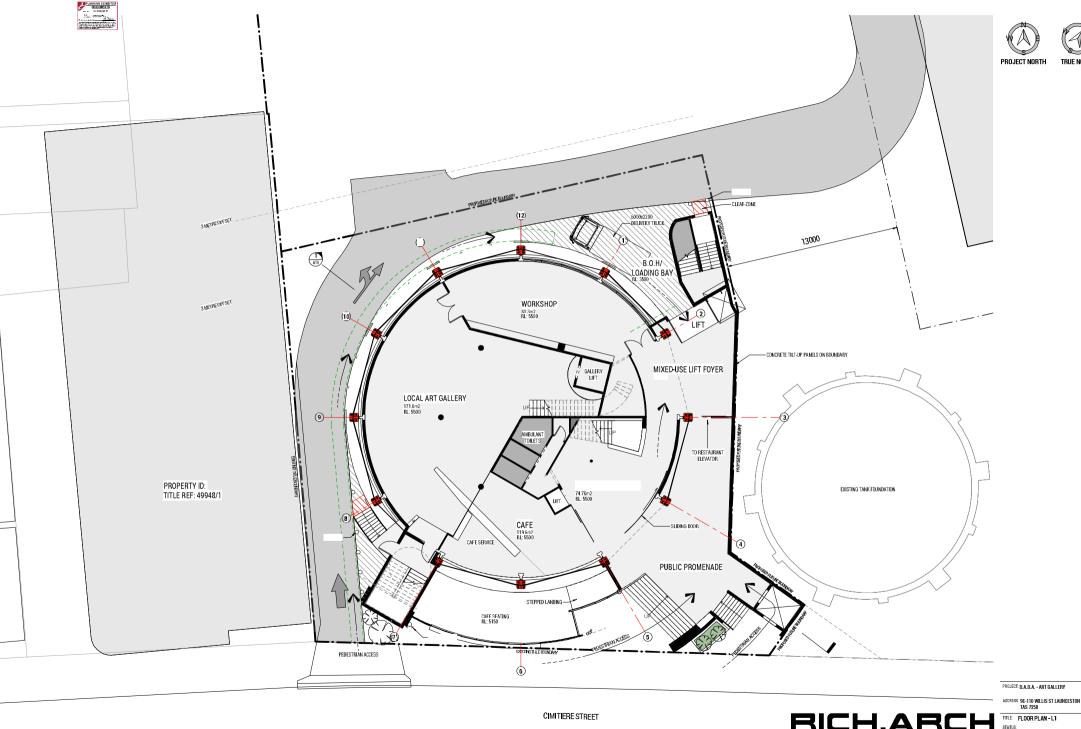

n. 1448340743 e. nchardgrarch.com.au

C AMENDED TO ANSWER RFT'S

B AMENDMENT TO DEVELOPMENT APPLICATION

A DEVELOPMENT APPLICATION RH 19-08-06 RH 19-07-29 RH 19-06-18 REV: DESCRIPTION: BY: DATE:

TITLE FLOOR PLAN - L1


DESIGN BY: R.H, J.C DRAWN BY: J.C DESIGN CHK: R.H. DPAFT CHK: RH
SCALE 1:100 SHEET SIZE: A1 DWGs IN SET:

PROJECT No. 18302 DWG No. AO2 REV. B APPROVED: RH ACRED. No: 002830 DATE: 19-06-18







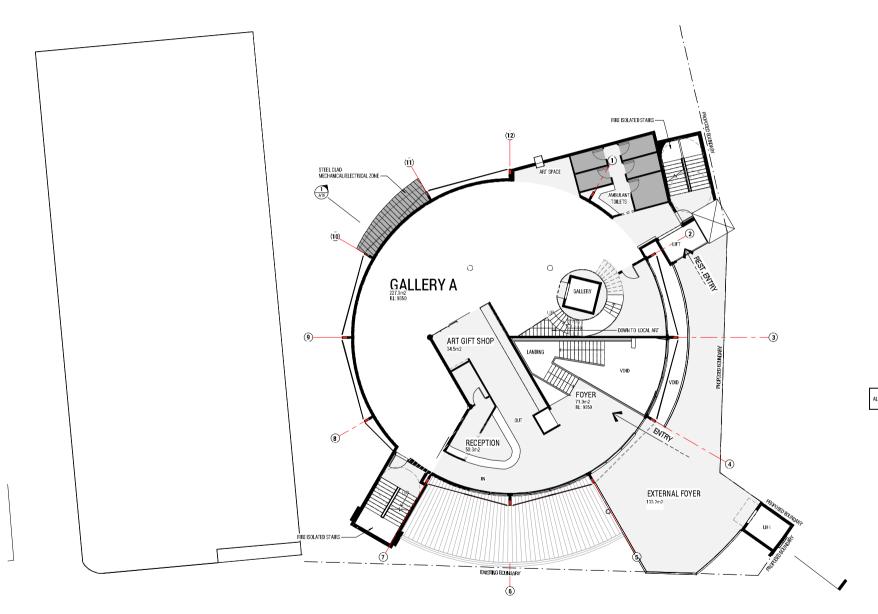

NOTE: ALL FUTURE EXTERNAL LIGHTING TO SHINE

PROJECT: D.A.D.A. - ART GALLERY

ADDRESS: 90-110 WILLIS ST LAUNCESTON TAS 7250

HARCH TILE FLOOR PLAN - L2


STATUS:
FOR PLANNING
DESIGN BY: RH,UC DRAWN BY: UC
DESIGN CHK: RH DRAFT CHK: RH
SACALE 1:100 SHEET SZE:AT DWGS IN SET
PROJECT No: 18302 DWG No: A03 REV: B

APPROVED: RH ACRED. No: 002830 DATE: 19-06-18







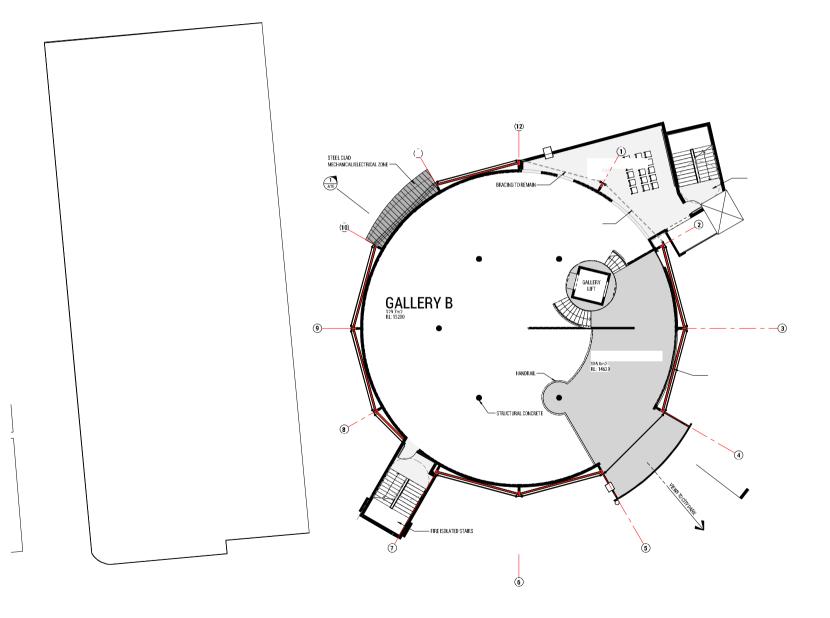

ADDRESS: 90-110 WILLIS ST LAUNCESTON TAS 7250


TITLE FLOOR PLAN - L3
STATUS:

STATUS:
FOR PLANNING
DESIGN BY: R.H.J.C DRAWN BY: J.C







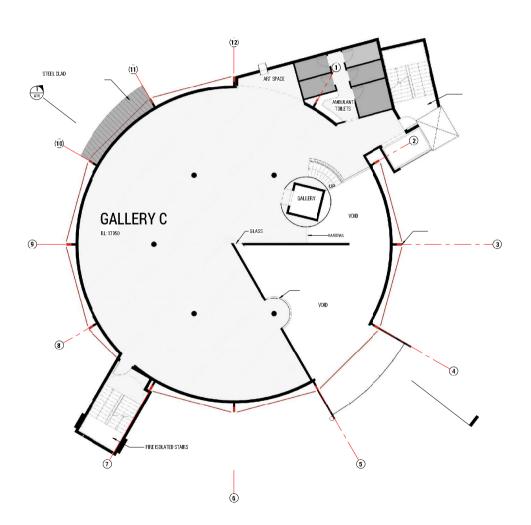

ADDRESS: 90-110 WILLIS ST LAUNCESTON TAS 7250

TITLE FLOOR PLAN - L4

ps 0408240742 e. nichar@parch.com au


C. AMENDED TO ANSWER REFS
B. AMENDMENT TO DEVELOPMENT APPLICATION
A. DEVELOPMENT APPLICATION
REV: DESCRIPTION:

STATUS.
FOR PLANNING
DESIGN BY: R.H.J.C. DRAWN BY: J.C.
DESIGN CH: R.H. DRAFTCHK: RH
SCALE 1: 100 SHEET SZE: A1 DWG3 IN SET: RH 19-08-06 RH 19-07-29 RH 19-06-18 BY: DATE: PROJECT No: 18302 DWG No: A05 REV: B APPROVED: RH ACRED. No: 002830 DATE: 19-06-18







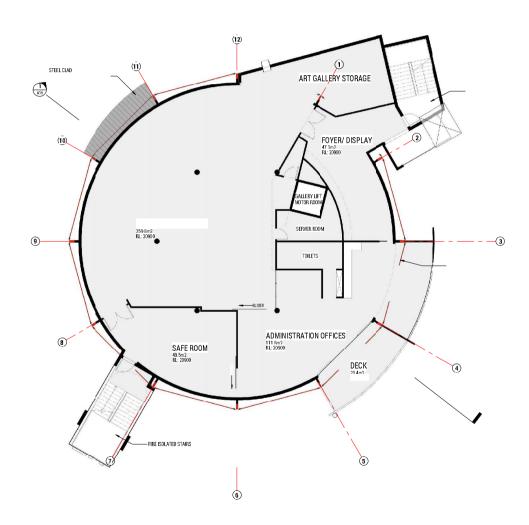

ADDRESS: 90-110 WILLIS ST LAUNCESTON TAS 7250

CH.ARCH THE FLOOR PLAN - L5


FOOR PLANT LS
STATUS:
FOR PLANNING
DESIGN CHK: R.H. DEPART CHK: RH
SCALE 1:100 SHEET SZE AI DWG: IN SET
PROJECT No: 18302 DWG No: A06 REV B

APPROVED: RH ACRED. No: 002830 DATE: 19-06-18







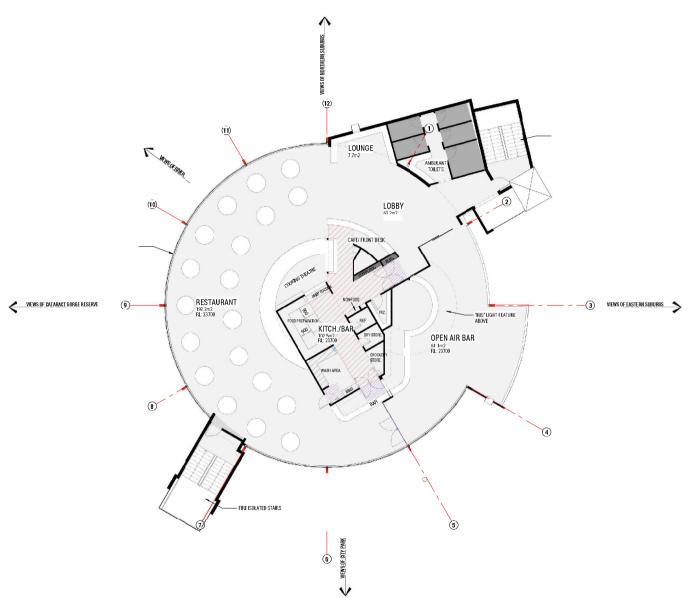

ADDRESS: 90-110 WILLIS ST LAUNCESTON TAS 7250

TITLE FLOOR PLAN - L6

RH 19-08-06 RH 19-07-29 RH 19-06-18

BY: DATE:

STATUS: FOR PLANNING

DESIGN BY: R.H.J.C DRAWN BY: J.C DESIGN CHK: R.H DRAFT CHK: RH


SCALE: 1:100 SHEET SIZE: A1 DWGs IN SET: PROJECT No. 18302 DWG No. A07 REV. B APPROVED: RH ACRED. No: 002830 DATE: 19-06-18

FLOOR PLAN - L6







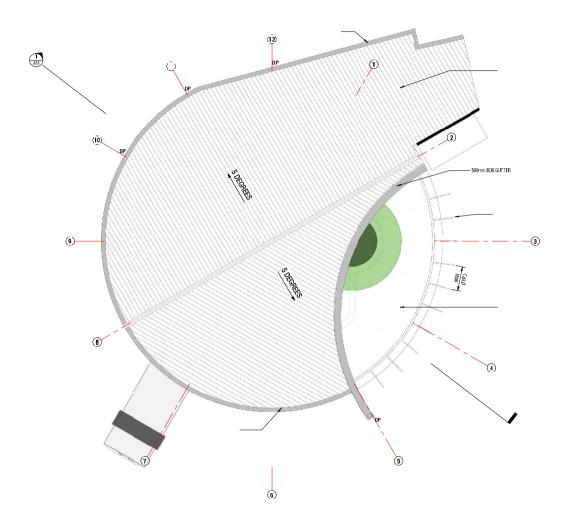

ROOFING PLAN

RICHARD HALL . ARCHITECT
p1.48834748 a. n.handgarch com au

C MMENDED TO ANSWER REFIG
B. MAENDMENT TO BEVELOPMENT APPLICATION RH 19-08-19
B. DEVELOPMENT APPLICATION RH 19-06-18
REV: DESCRIPTION: BY: DATE: RH 19-08-06 RH 19-07-29 RH 19-06-18 BY: DATE:


PROJECT: D.A.D.A. - ART GALLERY ADDRESS: 90-110 WILLIS ST LAUNCESTON TAS 7250

TITLE ROOFING PLAN

STATUS.
FOR PLANNING
DESIGN BY: R.H.J.C. DRAWN BY: J.C.
DESIGN DRIK. R.H. DRAFTCHK: RH.
SCALE 1: 100 SHEET SIZE: A1 DWO3: IN SET:

PROJECT No. 18302 DWG No. A08 REV. B

APPROVED: RH ACRED. No. 022830 DATE 19-06-18

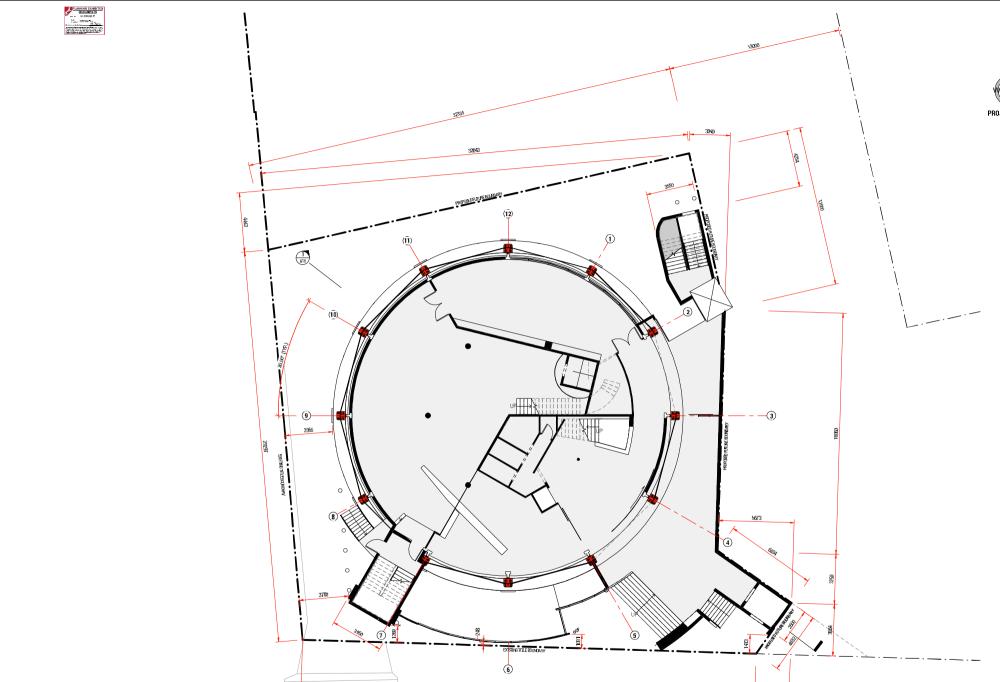


ADDRESS: 90-110 WILLIS ST LAUNCESTON TAS 7250

TITLE DIMENSIONED FLOOR PLAN - L1 DESIGN BY: R.H.J.C DRAWN BY: J.C







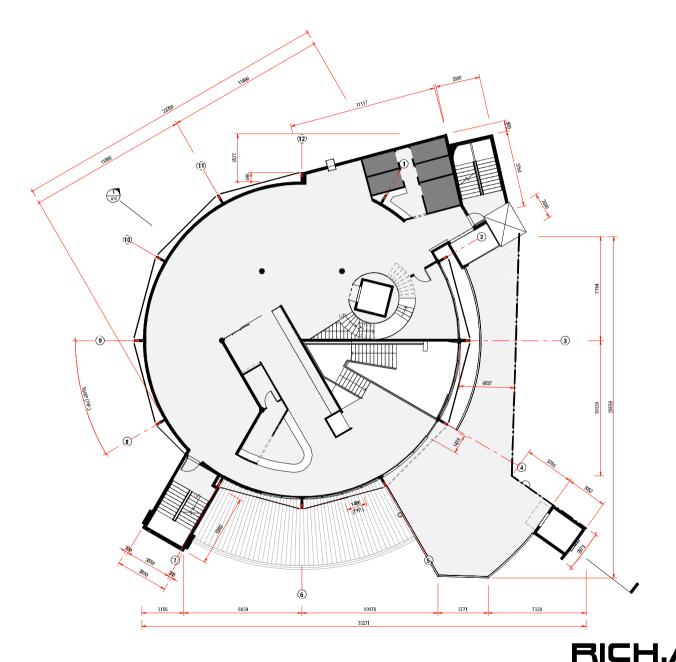

ADDRESS: 90-110 WILLIS ST LAUNCESTON TAS 7250

TITLE DIMENSIONED FLOOR PLAN - L2 STATUS: FOR PLANNING DESIGN BY: R.H.J.C DRAWN BY: J.C

ps 0408240742 e. nichar@parch.com au

C. AMENDED TO ANSWER REFS
B. AMENDMENT TO DEVELOPMENT APPLICATION
A. DEVELOPMENT APPLICATION
REV: DESCRIPTION:


RH 19-08-06 ... RH 19-07-29 ... RH 19-06-18 ... BY: DATE: DESIGN CHK: R.H DRAFT CHK: RH

SCALE: 1:100 SHEET SIZE: A1 DWGs IN SET: PROJECT No. 18302 DWG No. A10 REV. B APPROVED: RH ACRED. No: OC2830 DATE: 19-06-18







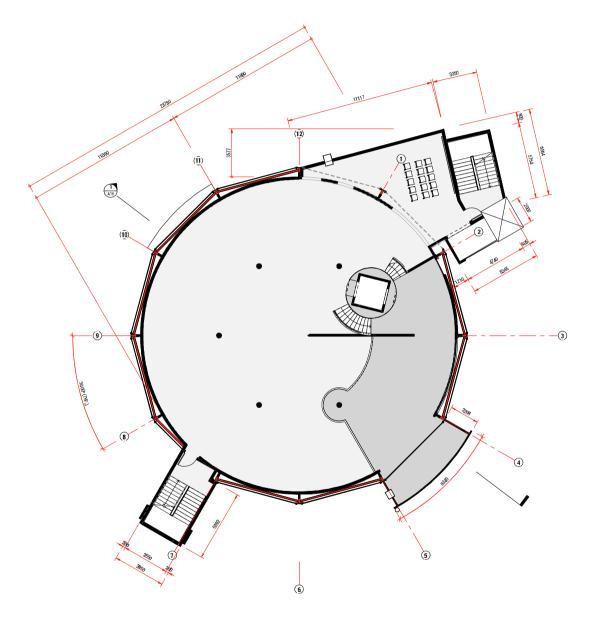

ADDRESS: 90-110 WILLIS ST LAUNCESTON TAS 7250

TITLE DIMENSIONED FLOOR PLAN-L3


C AMENDED TO ANSWER RFIS
B AMENDMENT TO DEVELOPMENT APPLICATION
REV: DESCRIPTION:

STATUS.
FOR PLANNING
DESIGNO PLAN, R.H.J.C. DRAWN BY: J.C.
DESIGNO CHIK. R.H. DRAFT CHIK. R.H.
SCALE 1: 100 SHEET SIZE: A1 DWO3: IN SET: RH 19-08-06 RH 19-07-29 RH 19-06-18 BY: DATE: PROJECT No: 18302 DWG No: A11 REV: B APPROVED: RH ACRED. No: 002830 DATE: 19-06-18







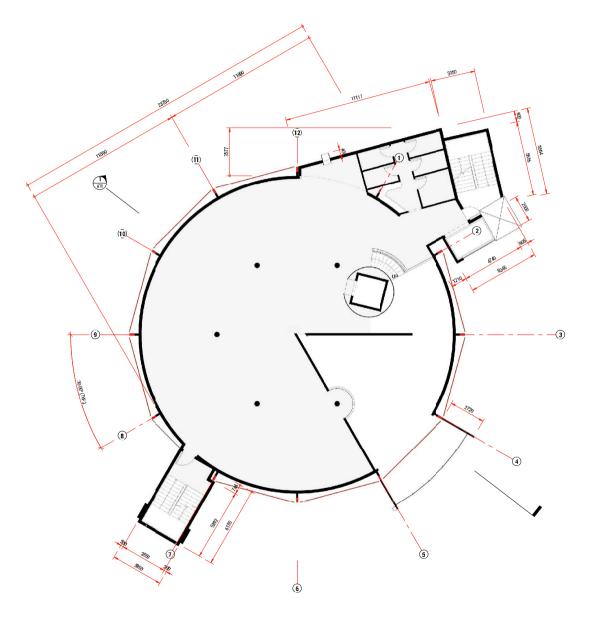

ADDRESS: 90-110 WILLIS ST LAUNCESTON TAS 7250

TITLE DIMENSIONED FLOOR PLAN-L4

STATUS.
FOR PLANNING
DESIGN BY: R.H.J.C DRAWN BY: J.C.
DESIGN BY: R.H.J.C DRAFTCHK: RH
SCALE 1:100 SHEET SZE: A1 DWG: IN SET.


PROJECT No. 18302 DWG No. A12 REV. B APPROVED: RH ACRED. No: 002830 DATE: 19-06-18

C AMENDED TO ANSWER RFIS
B AMENDMENT TO DEVELOPMENT APPLICATION
REV: DESCRIPTION: RH 19-08-06 RH 19-07-29 RH 19-06-18 BY: DATE:







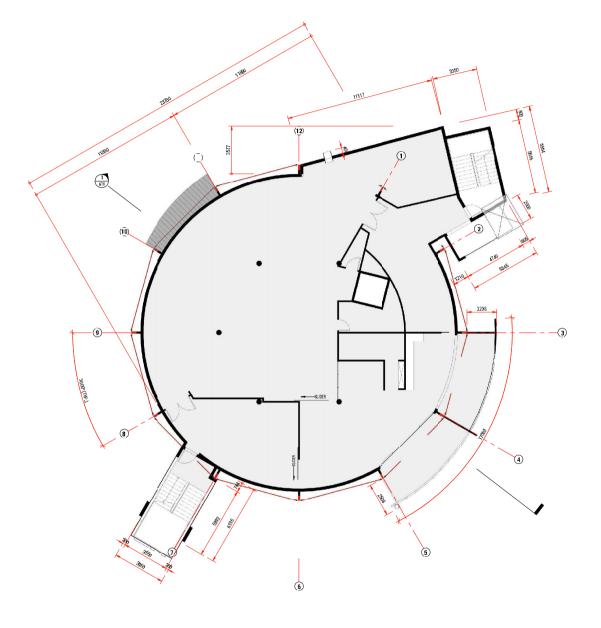

ADDRESS: 90-110 WILLIS ST LAUNCESTON TAS 7250

TITLE DIMENSIONED FLOOR PLAN-L5

RH 19-08-06 RH 19-07-29 RH 19-06-18 BY: DATE:

ps 0408240742 e. nichar@parch.com au

C. AMENDED TO ANSWER REFS
B. AMENDMENT TO DEVELOPMENT APPLICATION
A. DEVELOPMENT APPLICATION
REV: DESCRIPTION:

STATUS.

FOR PLANNING

DESIGN BY: R.H.J.C DRAWN BY: J.C.

DESIGN BY: R.H. DRAFTCHK: RH


SCALE 1:100 SHEET SZE: A1 DWG: IN SET. PROJECT No. 18302 DWG No. A13 REV. B APPROVED: RH ACRED. No: 002830 DATE: 19-06-18

DIMENSIONED FLOOR PLAN - L5







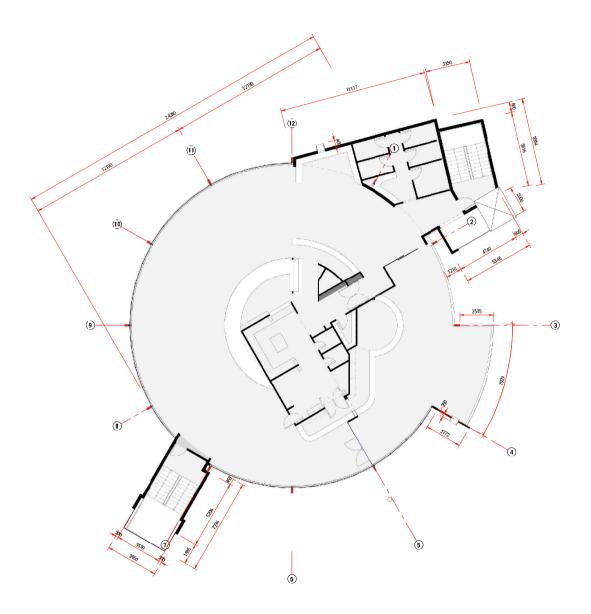

ADDRESS: 90-110 WILLIS ST LAUNCESTON TAS 7250

TITLE DIMENSIONED FLOOR PLAN- LG


RH 19-08-06 RH 19-07-29 RH 19-06-18 BY: DATE:

ps 0408240742 e. nichar@parch.com au

C. AMENDED TO ANSWER REFS
B. AMENDMENT TO DEVELOPMENT APPLICATION
A. DEVELOPMENT APPLICATION
REV: DESCRIPTION:

STATUS.
FOR PLANNING
DESIGN BY: R.H.J.C DRAWN BY: J.C.
DESIGN BY: R.H.J.C DRAFTCHK: RH
SCALE 1:100 SHEET SZE: A1 DWG: IN SET. PROJECT No: 18302 DWG No: A14 REV: B APPROVED: RH ACRED. No: 002830 DATE: 19-06-18



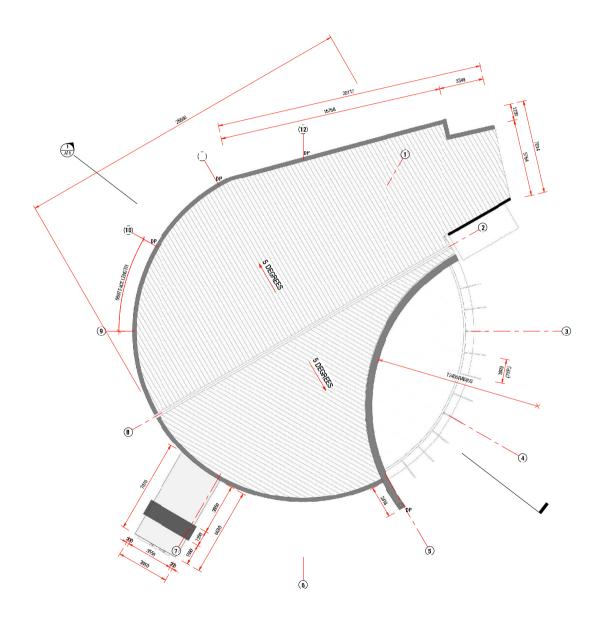


ADDRESS: 90-110 WILLIS ST LAUNCESTON TAS 7250



| TITLE | DIMENSIONED ROOFING PLAN | STATUS | ST



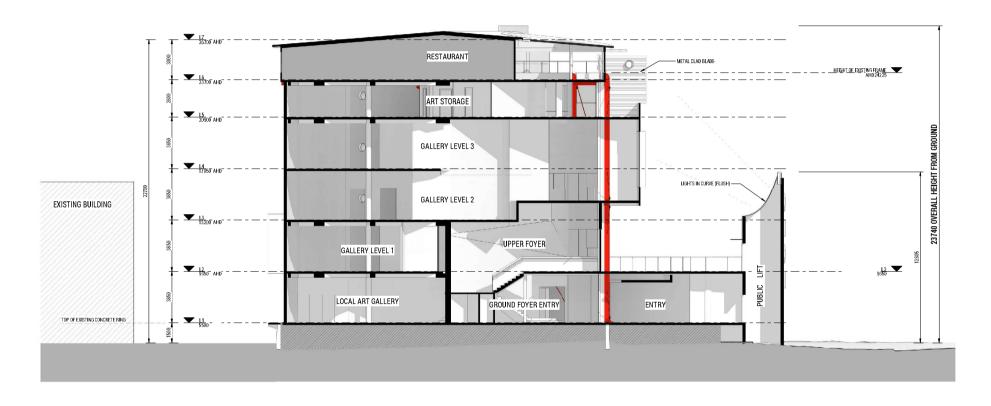

SECTION




ADDRESS: 90-110 WILLIS ST LAUNCESTON TAS 7250

TITLE SECTION - SHEET 1

R I C	RICHAR HARDHALL ARC		
С	AMENDED TO ANSWER RFI's	RH	19-08-06
В	AMENDMENT TO DEVELOPMENT APPLICATION	RH	19-07-29
Α	DEVELOPMENT APPLICATION	RH	19-06-18
REV:	DESCRIPTION:	BY:	DATE:

| STATUS | S



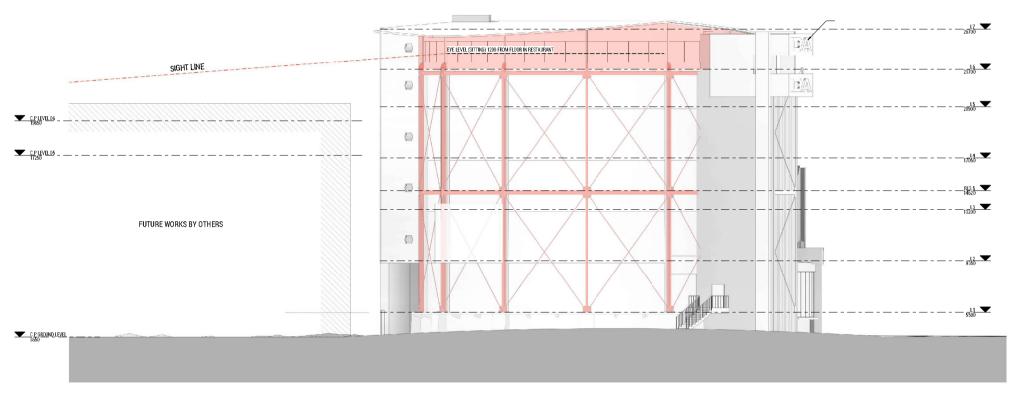

SECTION - RESTAURANT SITE LINE

ADDRESS: 90-110 WILLIS ST LAUNCESTON TAS 7250

RICHARDHALL ARCHITECT

BICHARDHALL ARCHITECT

| DESIGN CHK: R.H. | DPAFT CHK: R.H. | SCALE: 1: 100 | SHEET SIZE: A1 | DWG: IN SET: | ENGINEER | SIZE: A1 | DWG: IN SET: | ENGINEER | SIZE: A1 | DWG: IN SET: | SIZE: A1 | DWG: IN SET





SOUTH ELEVATION

PROJECT: D.A.D.A. - ART GALLERY

SCHEDULE OF FINISHES

91 DOTG GASOMATER FRAME
COLOUT DI BRAMAN GO B. TREATED TO PRESERVE

92 PAINTED RIVETED STEEL FAMEL CLARDING (YPP)
HERT FACE BREEN HIS MINICAL, SEMI OLIOSS FRINCH

103 PREAST THE PER CONCRETE FRANKES, NAUTURAL FRINSH

104 SOLIPTURAL ELEMENTS, COPPER TURING

105 LARGE DA AS GOR BOCK UT

106 COCREDION ROOFING, BRASALT OR SIMILAR

107 ARTISTE MEMBAL STYLE PARATTE BRADE WALL FULL HEIGHT

108 METAL BRADE WALL, DALY FINISH

109 COPPER TAT SHEET CARDING MY PAINTS WITH FRINFF APPRING

100 COPPER TAT SHEET CARDING MY PAINTS WITH FRINFF APPRING

09 COPPER FLAT SHEET CLADDING IN PANELS WITH OVERLAPPING FLAT SEAMS & SUBTLE RIVETS, NATURAL FINISH

01 EXTG. GASOMETER FRAME

ADDRESS: 90-110 WILLIS ST LAUNCESTON TAS 7250

TITLE ELEVATION - SHEET 1 STATUS: FOR PLANNING


DESIGN BY: R.H, J.C DRAWN BY: J.C DESIGN CHK: R.H. DRAFT CHK: RH
SCALE: 1:100 SHEET SIZE: A1 DWGs IN SET:

PROJECT No: 18302 DWG No: A18 REV: B APPROVED: RH ACRED. No: 002830 DATE: 19-06-18

RICHARD HALL ARCHITECT h.0408340743 e. nchard@rarch.com.au

C AMENDED TO ANSWER RFI's RH 19-08-06 B AMENDMENT TO DEVELOPMENT APPLICATION
A DEVELOPMENT APPLICATION RH 19-07-29 RH 19-06-18 REV: DESCRIPTION: BY: DATE:



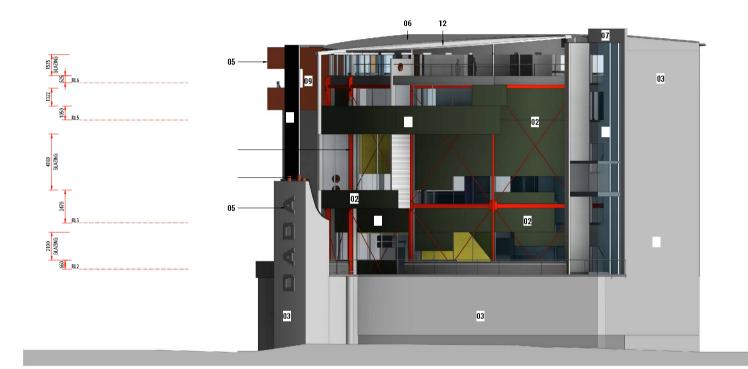

EAST ELEVATION

ADDRESS: 90-110 WILLIS ST LAUNCESTON TAS 7250

D2 PAINTED RIVETED STEEL PANEL CLADDING (TYP.)
HERITAGE GREEN OR SIMILAR, SEMI GLOSS FINISH

HEBITACE GREEN IS SIMMAR, SOM IGLOSS FINSH

OF PREASOT HILD PEDROBERS FEMELS NATURAL FINSH

OF SULPTURAL ELBERIST, COPPER TURNS

OF LARGE DA A SISK PARCULT

OF COURSEAND ROOMEN, BASIAT OR SIMMAR

OF ARTISTIC MURAL STYLE PAINTED BLADEWALL FULL HE

OF LARGE ALL ROUGH FRAIL, SALV FINSH

OF OPPER FLAT SHEET CLADINGS IN PARCLS WITH OVER

FLAT STAMPS, SOURTE FINST SAUTHORS FINSH

FLAT STAMPS, SOURTE FINST SAUTHORS FINSH

THE STAMPS OF SOURTE FINST SAUTHORS FINSH

OF SOURTE FINST SAUTHORS FINSH

THE STAMPS OF SOURTE FINST SAUTHORS FINSH

OF SOURTE FINST SAUTHORS

OF SOURCE FINST SAUTHORS

OF SOURTE FINST SAUTHORS

OF SOUR

10 INDUSTRIAL RIVETED DARK METAL CLADDING, COLORBI MONUMENT OR SIMILAR MONOMEN US SIMILAR

11 COPPER EXTRIDED WINDOW FRAME, NATURAL FINISH

12 TRANSLUCENT ROOFING - DANPALON OR SIMILAR

13 COLORBOND SPANDEX, SHALE OREY OR SIMILAR

14 LIGHT GERY FEFFECTIVE TITY, SILVER FRAMES OR SIMIL

15 GLASS & GALV. METAL ELEVATOR CAR & MECHANISM / I

15 GASSA GALV. METAL ELEVATORIC CAR & MECHANISM' I 16 EXTIG DEFORM CONCERTE EASERING, TO ERANAMI I 17 METAL & MISH CLAD MECH. & ELECTRICAL ENCLOSURE (APPROX.) 18 PAINTED DOOR NEUTRAL GREY OR SIMILAR SLOTTED OPENINGS RESEMBLE EXTG. GASOMETER FRA WITHIN

TITLE ELEVATION - SHEET 2 STATUS: FOR PLANNING

DESIGN BY: R.H, J.C DRAWN BY: J.C

DESIGN CHK: R.H. DRAFT CHK: RH


SCALE: 1:100 SHEET SIZE: A1 DWGs IN SET: PROJECT No: 18302 DWG No: A19 REV: B APPROVED: RH ACRED. No: 002830 DATE: 19-06-18

ph.0408340743 e. nchard@rarch.com.au

C AMENDED TO ANSWER REI's RH 19-08-06 RH 19-07-29 RH 19-06-18 B AMENDMENT TO DEVELOPMENT APPLICATION
A DEVELOPMENT APPLICATION REV: DESCRIPTION: BY: DATE:

Document Set ID: 4126888 Version: 3, Version Date: 86/89/2019



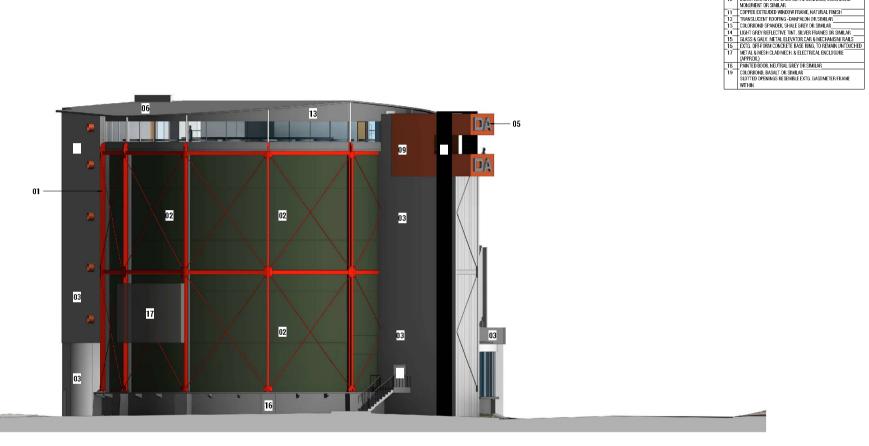

WEST ELEVATION

PROJECT: D.A.D.A. - ART GALLERY

SCHEDULE OF FINISHES No. DESCRIPTION
01 EXTG. GASOMETER FRAME COLOUR TO REMAIN AS IS & TREATED TO PRESERVE

OZ PAINTED RIVETED STEEL PANEL CLADDING (TVP.)
HERITAGE GREEN OR SIMILAR, SEMI GLOSS FINISH

HEBITAGE GREEN OR SIMILAR, SEM GLOSS FINISH
DO PRECAST ILLY BOUNDERF PANELS, NATURAL FINISH
D4 SCHPUTBAL ELEMBATS, COPPERTURISH
D5 LARGE DA J SIGN BACKUT
D6 COCORREND BOOTHER, BASALT DR SIMILAR.
D7 ARTISTS LEMBAL STUFF PANELS AND BE AND WALL FULL HEIGHT
D6 METAL BLAGE WALL GALV FINISH
D6 METAL BLAGE WALL GALV FINISH
D7 ARTISTS LETT SHEET CLARDING IN PANELS WITH OFERLAPPING
HAT STANDS SUBTLE BRIVETS NATURAL FINISH
D MONETAR BRIVETED DARK METAL CLARDING, COLORBOND
D MONIMER BRIVETED DARK METAL CLARDING, COLORBOND

ADDRESS: 90-110 WILLIS ST LAUNCESTON TAS 7250

TITLE ELEVATION - SHEET 3 STATUS: FOR PLANNING


DESIGN BY: R.H, J.C DRAWN BY: J.C


DESIGN CHK: R.H. DRAFT CHK: RH SCALE: 1:100 SHEET SIZE: A1 DWGs IN SET: PROJECT No. 18302 DWG No. A20 REV. B

RICHARDHALL ARCHITECT ph.0408340743 e. nchard@rarch.com.au

C AMENDED TO ANSWER REI's RH 19-08-06 RH 19-07-29 RH 19-06-18 B AMENDMENT TO DEVELOPMENT APPLICATION
A DEVELOPMENT APPLICATION REV: DESCRIPTION: BY: DATE: APPROVED: RH ACRED. No: 002830 DATE: 19-06-18



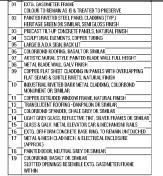

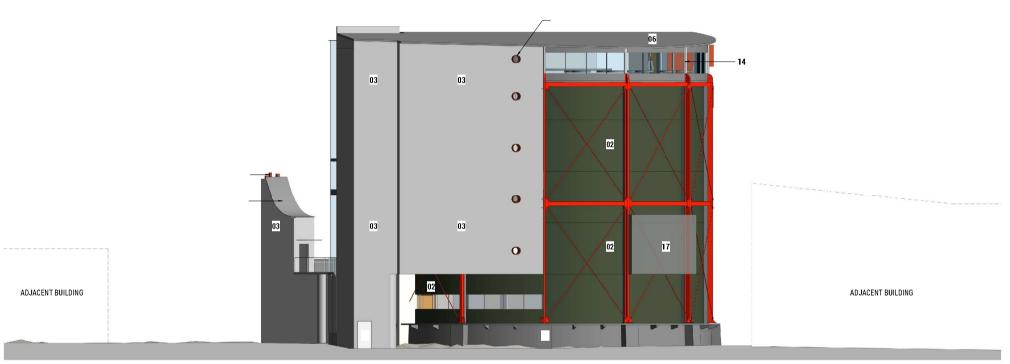

NORTH ELEVATION

ADDRESS: 90-110 WILLIS ST LAUNCESTON TAS 7250

APPROVED: RH ACRED. No: 002830 DATE: 19-06-18

TITLE ELEVATION - SHEET 4 STATUS: FOR PLANNING

DESIGN BY: R.H, J.C DRAWN BY: J.C DESIGN CHK: R.H. DRAFT CHK: RH SCALE: 1:100 SHEET SIZE: A1 DWGs IN SET: PROJECT No: 18302 DWG No: A21 REV: B

RICHARDHALL ARCHITECT h.0408340743 e. nchard@rarch.com.au

C AMENDED TO ANSWER RFI's B AMENDMENT TO DEVELOPMENT APPLICATION
A DEVELOPMENT APPLICATION

RH 19-08-06 RH 19-07-29 RH 19-06-18 REV: DESCRIPTION: BY: DATE:





VIEW FROM CITY PARK SIDE GATE

PROJECT: D.A.D.A. - ART GALLERY

ADDRESS: 90-110 WILLIS ST LAUNCESTON TAS 7250

RICHARCH TIME 30 VIEW - SHEET I

STATUS
FOR FLANNING
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SCALE: SHEET SEZE A1 DWO3 IN SET.
PROJECT NR: R 8302 DWG NR A22 REV. B
APPROVED RM ACRED NR: D2230 DATE 19-44-18

Document Set ID: 4126388





VIEW FROM ALBERT HALL STEPS

ADDRESS: 90-110 WILLIS ST LAUNCESTON TAS 7250

TITLE 3D VIEW - SHEET 2

STATUS
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PROJECT: D.A.D.A. - ART GALLERY

ADDRESS: 90-110 WILLIS ST LAUNCESTON TAS 7250

TITLE 3D VIEW - SHEET 3

STATUS: SECTION SECTIO PROJECT No. 18302 DWG No. A24 REV. B
APPROVED: RH ACRED. No. O22830 DATE 19-06-18

pn.440340742 a.nchadgnarch.com.au

C. AMENDED TO ANSWER RFTS
B. AMENDMENT TO DEVELOPMENT APPLICATION
A. DEVELOPMENT APPLICATION
REV: DESCRIPTION: RH 19-08-06 RH 19-07-29 RH 19-06-18 BY: DATE:





VIEW FROM CORNER OF CIMITIERE ST & WILLIS ST

ADDRESS: 90-110 WILLIS ST LAUNCESTON TAS 7250

TITLE 3D VIEW - SHEET 4

STATUS:
FOR PLANNING
DESION BY: R.H.J.C. DRAWN BY: J.C.
DESION CHI: R.H. DRAFT CHI: RH
SCALE: SHEET SIZE: A1 DW03 IN SET.

SCALE SHEET SIZE: A1 DWG 8 IN SET:
B PROJECT No. 18302 DWG No. A25 REV. B








ADDRESS: 90-110 WILLIS ST LAUNCESTON TAS 7250

HARCH TIRE

n.04083407	143 e. nchard@rarch.com.au		
С	AMENDED TO ANSWER RFI'S	RH	19-08-06
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ADDRESS: 90-110 WILLIS ST LAUNCESTON TAS 7250

3 PROPOSED - 21st JUNE - 3pm

ps 0408240742 e. nichar@parch.com au

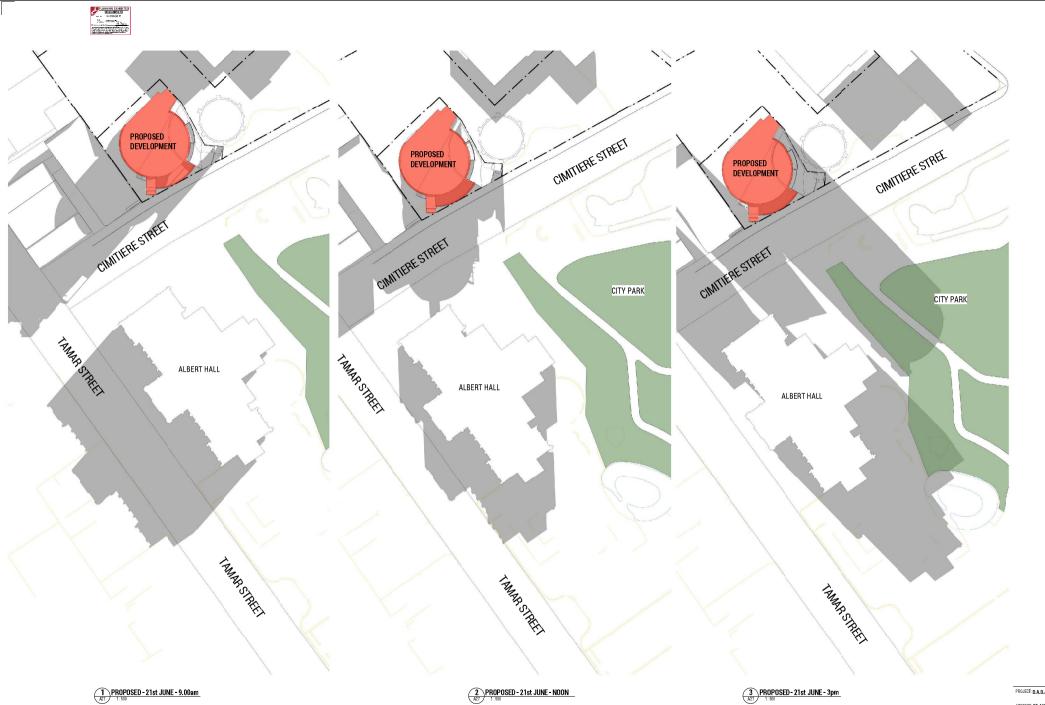C. AMENDED TO ANSWER REFS
B. AMENDMENT TO DEVELOPMENT APPLICATION
A. DEVELOPMENT APPLICATION
REV: DESCRIPTION: RH 19-08-06 RH 19-07-29 RH 19-06-18 BY: DATE:

STATUS: PROPOSED FOR PLANNING DESIGN BY: R.H.J.C DRAWN BY: J.C

DESIGN CHK: R.H DRAFT CHK: RH
SCALE: 1:500 SHEET SIZE: A1 DWGs IN SET: PROJECT No: 18302 DWG No: A27 REV: B APPROVED: RH ACRED. No: 002830 DATE: 19-06-18



1 Cooper Crescent Riverside TAS 7250 M: 0456 535 746 P: 03 6334 1868

E: Richard.burk@trafficandcivil.com.au

8th August 2019

Mr Andrew Goelst

General Manager

rare.

Level 1A,

10-14 Paterson Street

Launceston 7250

RE: CIMITIERE GASWORKS SITE REDEVELOPMENT PARKING ADVICE

This letter is to provide advice on parking associated with the proposal and interpretation of Launceston Interim Planning Scheme 2015 requirements.

1) Parking Demand (Planning scheme requirements)

See figure 1 on the following page which summarises Planning Scheme Table E6.1 requirement, an indicated requirement of 106 spaces in total.

Traffic & Civil Services

Page 1





Figure 1 – Interpretation of Planning Scheme Table E6.1 requirement

Use	Parking Demand rate (GFA)	Concept Plan Floor Area (m²)	Requirement
Ground Floor			
Local Art gallery	No set requirement	171	12
Workshop	(say 1/20m²)	81	
Café	1 space / 15m²	120	8
Ground Floor To	tal	372	20
Level 2			
Gallery	1 / 202	227	11
Reception	1 space / 20m²	50	2
Gift Shop	1 space / 15m²	35	2
Level 2 Total	*	312	15
Level 3		0.0	
Gallery	1 space / 20m²	482	24
Level 3 Total		482	24
Level 4			
Gallery	1 space / 20m²	325	16
Level 4 Total		325	16
Level 5			
Store	1 space / 180m²	260	1
Safe	1 space / 180m²	50	0
Administration	1 space / 15m²	112	7
Level 5 Total		422	8
Level 6			
Restaurant	1 cpass / 15m²	192	13
Kitchen	1 space / 15m²	102	7
Open Air Bar	1 space / 20m²	61	3
Lobby	No	63	
Lounge	requirement	8	
Level 6 Total		426	23





2) Parking Supply and Demand

2.1) Public off-street (See Appendix B and C)

• Proposed 230 space multi storey carpark behind this development (Demand 146 spaces)

The proposed multi storey carpark behind this development is subject to a separate Development Application currently. Therefore, no guarantee can be provided that the available spaces from this proposed carpark will be available once DADA is operational. However, the two proponents are collaborating to enable this to occur.

• Existing 170 space Willis St. (Demand 146 spaces)

It is noted that the existing Willis Street carpark site has been sold to the University of Tasmania and will be redeveloped therefore making these spaces unavailable once the University development commences.

Current spare capacity 84 spaces.

2.2) Public on-street (See Appendix D)

• Cimitiere St. (Tamar - Lawrence) - supply 38, demand 38

Allows for the proposed loss of 9 spaces for a pedestrian crossing of Cimitiere Street in the vicinity of Willis Street.

- Lawrence St. (Cimitiere Brisbane) supply 30, demand 20
- Brisbane St. (Tamar St Lawrence) supply 30, demand 23

Spare capacity 17 spaces (midday, midweek).

Estimated spare capacity with public parking of 100 spaces.





2.3) Private off street (See Appendix E)

- A- Office supply 43, demand 40
- B- Private supply 33, demand 23
- C- Private supply 28, demand 18
- D- Business supply 7, demand 5

i.e. supply of 111 and demand for 86 spaces

Estimated spare capacity with private parking of 25 spaces.

4) Conclusions and Recommendations

The planning scheme requirement is estimated at 106 parking spaces required for the development.

Spare public parking is currently estimated at 40 spaces midday, midweek and significantly more after 6pm although there are various other parking opportunities within a short walk of the site including Inveresk and many more on-street spaces.

A 230-space multi-storey car park is proposed by an independent developer adjacent to the proposal which is expected to be able to supply an additional 84 spaces once complete and the Willis Street carpark becomes unavailable.

Parking demand varies with time of day. To provide an indication of typical demand, estimates in this report are based on preliminary observations at midday and midweek.

Operation of the proposed facility consists of two modes:

- Café and art gallery (Levels 1-4) operating 9am to 5pm Mon-Sun.
- Restaurant and bar (Level 6) operating 12pm to 10pm Mon Sun.

Clearly, the modes of operation overlap in terms of parking demand from the complex with the peak occurring around lunchtime.

Estimated spare public parking capacity, within walking distance, between 9am and 5pm is over 100 spaces including the Inveresk precinct. This shows that the





proposal does not need to supply customer parking to satisfy demand. Significantly, in addition a 230space multi-storey public carpark is proposed adjacent the site by an independent developer. This facility is expected to operate at complimentary times and once constructed effectively overcomes any potential parking supply concerns.

23 spaces late afternoon and evenings with the restaurant and bar.

Estimated spare public parking capacity between 6pm and 10pm will be greater than 100 spaces as peak demand has passed by this time of day. It is estimated that customers would be able to park on or off street within walking distance of the restaurant late afternoon and evening, noting that the proposed multi-story car park may not be operational by the time this development is complete.

Accordingly, it is suggested that parking demand arising from the proposal can be easily satisfied with existing parking supply for staff, visitors and to meet disability parking requirements.

7) Assessor Credentials

Richard Burk is a qualified Traffic and Civil Engineer with over 30 years of experience with State and Local Government in the Roads and Traffic industry in Tasmania. Visit www.trafficandcivil.com.au.

Yours sincerely



Director

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